



INSTALLING CONTRACTOR IS RESPONSIBLE TO VERIFY ALL MEASUREMENTS PRIOR TO ANY WARMBOARD INSTALLATION.

TYPE

QUANTITY

COMMENTS

S

PANEL SCHEDULE

S

二

MANDATORY

FOLLOW ALL WARMBOARD INSTALLATION INSTRUCTIONS AND RPA GUIDELINES.

ᄱ

 $|\omega|\omega$

双广

ㅁ

ယ

(-)

(N)

ס

0

 \bigcirc

USE ONLY WARMBOARD APPROVED TUBING.

USE AN APPROPRIATELY WEIGHTED ROLLER TO PRESS TUBING INTO CHANNELS.

DOUBLE PANELS WILL CONSIST OF A "HALF DOUBLE-LEFT" PANEL AND A "HALF DOUBLE-RIGHT" PANEL. ON THE PANEL LAYOUT, YOU MAY SEE A PANEL MARKED AS "HD-L" OR "HD-R." THIS MEANS THAT YOU CUT ONE OF THESE DOUBLE PANELS IN HALF AND USE THE APPROPRIATE SIDE AS MARKED FOR THE INSTALLATION.

CONVENTIONAL TONGUE AND GROOVE PLYWOOD PANELS USED TO FILL IN EMPTY SPACES WHERE WARMBOARD MAY NOT BE APPROPRIATE.

ANY PANELS IN THE DRAWING THAT ARE MARKED WITH ASTERISK (*) INDICATE A PANEL THAT IS TO BE TRIMING CAREFUL MEASUREMENT SHOULD BE MADE TO GUAFA CORRECT INSTALLATION.


TH AN MED. A SANTEE

ᅏᅼ

O

QUESTIONS? FOR IMMEDIATE ASSISTANCE (1-877-338-5493 (8am - 5pm PST)



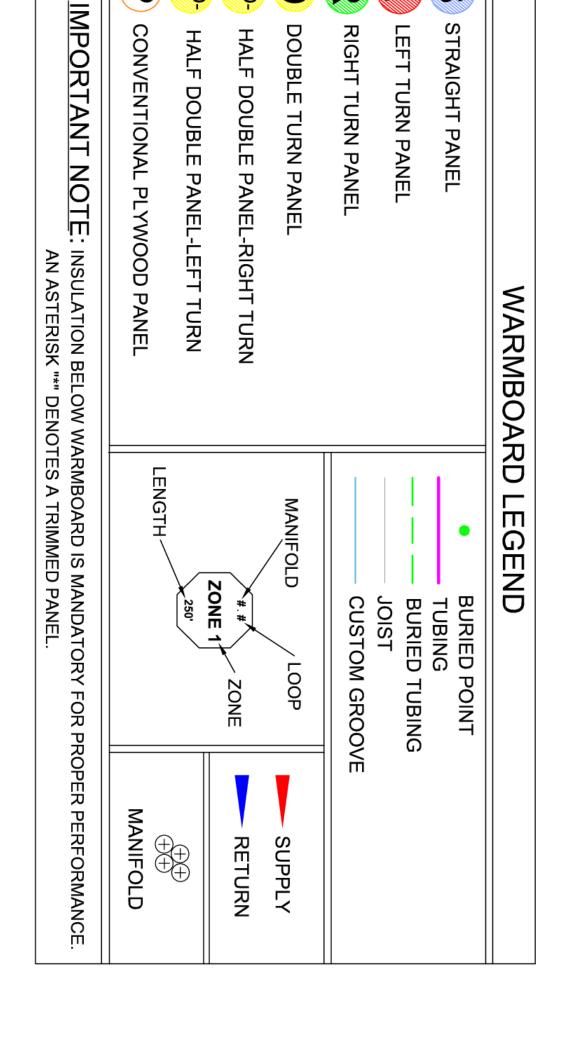

Qī	OF STRAIGHT ROUTES
	TOTAL LINEAR LENGTH
9	TURNS
JTES	ESTIMATED CUSTOM ROUTES

TOTAL LINEAR LENGTH	TURNS	ESTIMATED CUSTOM ROUTES
ΩĪ	9	JTES

OF STRAIGHT ROUTES	TOTAL LINEAR LENGTH	TURNS	ESTIMATED CUSTOM ROUTES
٥	<u>ה</u>	9	Ċ.

	ZONE 1	ZONE 1	ZONE 1	ZONE	
TOTAL	1	1	1	MANIFOLD	LOOP SCHEDULE
	3	2	1	LOOP	IEDUL
635'-0"	235'	255'	145'	LENGTH	Ш

RICE 1054HOUSE ADDITION
JOB # 25181
WA USA



WARDROBE

BE 무

õ

BURY TUBE ZONE IF NECESSARY. FLOORING TO BE OPENED AT SOME POINT OF CONSTRUCTION.

CUSTOM GROOVE MAY BE REQUIRED A MINIMUM OF 6" FROM WAX RING

WARMBOARD, INC.
8035 SOQUEL DR. SUITE 41-A
APTOS, CA 95003

CUSTOM GROOVE MAY BE REQUIRED TO AVOID RUNNING TUBING BENEATH THE LENGTH OF THIS WALL

VOICE: (877)338-5493 FAX: (831)685-9278 WWW.WARMBOARD.COM EMAIL: PLANS@WARMBOARD.COM

LOAD BEARING WALL

DECK

TER R

BE)R

BURY TUBE ZONE IF NECESSARY. FLOORING TO BE OPENED AT SOME POINT OF CONSTRUCTION.

REVISIONS:

BY:

CUSTOM GROOVE TYP

BA.LH

유 2

DATE: 09-29-09

SCALE: 1/4" = 1'

DRAWN: D.EBERLY

REVIEWED:J.McDONALD

PANEL/TUBING **LAYOUT**

THIS WARMBOARD **DESIGN** CONS PECIF J ÀNEL UBING, NIFOLDS

REVISIONS

WARMBOAR D SHOP DRAWINGS DO NOT INCLUDE THE FOLLOWING:

ROOM BY ROOM HEAT LOSS CALCULATIONS
PROPER DESIGN OF FLOW RATES AND REQUIRED WATER TEMPERATURES
SIZING OF CIRCULATIONS PUMPS AND DISTRIBUTION LINES
SIZING AND SPECIFYING HEAT SOURCE AND MECHANICAL BOILER TRIM
COMPLETE ELECTRONIC CONTROL STRATEGY

WARMBOARD INC HIGHLY RECOMMENDS CONSULTING WITH A QUALIFIED RADIANT DESIGNER OR MECHANICAL CONTRAC TOR FOR DOCUMENTATION.

WHEN Z DOUBT,

SCALE:

Z O Z M


Please review all installation instructions. If there are any questions or need for technical assistance call: 1 877 338-5493

QTY DESCRIPTION	NOTES
MANIFOLD & TUBING MATER	RIALS LIST

	MANIFOLD & LODING MAI DA	ALO LIO I
QTY	DESCRIPTION	NOTES
	1000' X 1/2" PEX AL PEX ROLL	
_	500' X 1/2" PEX AL PEX ROLL	[1.1,1.2]
_	300' X 1/2" PEX AL PEX ROLL	[1.3]
	HOME RUN SUPPLY & RETURN	
	2 PORT SUPPLY & RETURN MANIFOLD KIT	
1	3 PORT SUPPLY & RETURN MANIFOLD KIT	SINGLE ZONED
	4 PORT SUPPLY & RETURN MANIFOLD KIT	
	5 PORT SUPPLY & RETURN MANIFOLD KIT	
	6 PORT SUPPLY & RETURN MANIFOLD KIT	
	7 PORT SUPPLY & RETURN MANIFOLD KIT	
	8 PORT SUPPLY & RETURN MANIFOLD KIT	
	9 PORT SUPPLY & RETURN MANIFOLD KIT	
	10 PORT SUPPLY & RETURN MANIFOLD KIT	
3 prs.	1/2" COMPRESSION FITTINGS (by pairs)	
0	24 VOLT ACTUATORS	

WARMBOARD SUBFLOOR INSULATED SUPPLY AN PIPING TO SUPPLY AND OR COF TEMPERATURE COPPER TO PEX UNION (COMPRESSION TYPE) SHUTOFF ED (MIN R-4): AND RETURN TO MANIFOLD AIR SILL PLATE HOSE BIB VENT VALVE GAGE STUD ВАҮ JOIST SPACE Ø STUD BAY TRIMMER, RIP ½" DOWN TO ACCOMMODATE PLYWOOD BACKING 1/2"PEX-AL-PEX TUBING COMPRESSION FITTING BALANCE VALVE RETURN MANIFOLD SUPPLY MANIFOLD 2x HEADER ZONE VALVE OR ZONE PUMP (MAY BE PLACED IN MECHANICAL ROOM FOR HOME RUN APPLICATIONS) BLOCKING JOIST SIDE VIEW - 2X6 WALL STUD OF 2X4 WALL (MIN 5-CAVITY REQ.) WARMBOARD PANEL GOODS (DRYWALL, ETC.) |の|౮|

SCALE: Z O Z M Ш ហ 刀 П

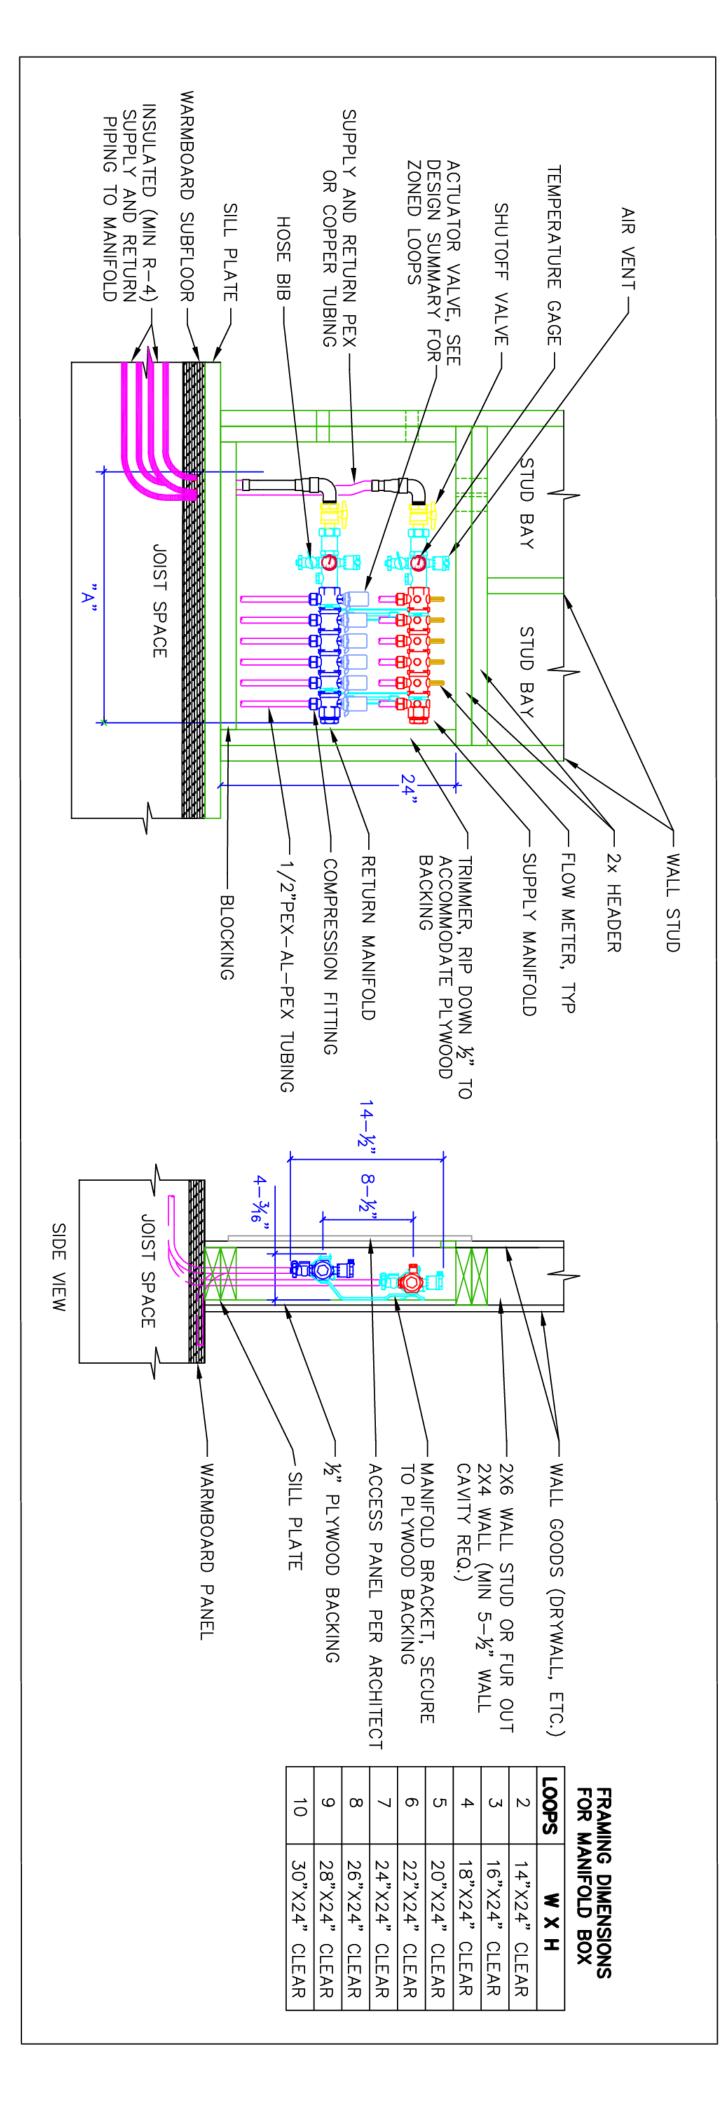

RADIANT SUBFLOOR

WARMBOARD, INC. 8035 SOQUEL DR. SUITE 41-A

APTOS, CA 95003 VOICE: (877)338-5493 FAX: (831)685-9278 WWW.WARMBOARD.COM EMAIL: PLANS@WARMBOARD.COM

REQUIRE

2 OF 2	SHEET:	REVIEWED;J.McDONALD	DRAWN: D.EBERLY	SCALE: NTS = 1'	DATE: 09-29-09


LAYOUT

TUBING & MANIFOLD RICE 1054HOUSE ADDITION

WA, USA

JOB # 25181

warmboard

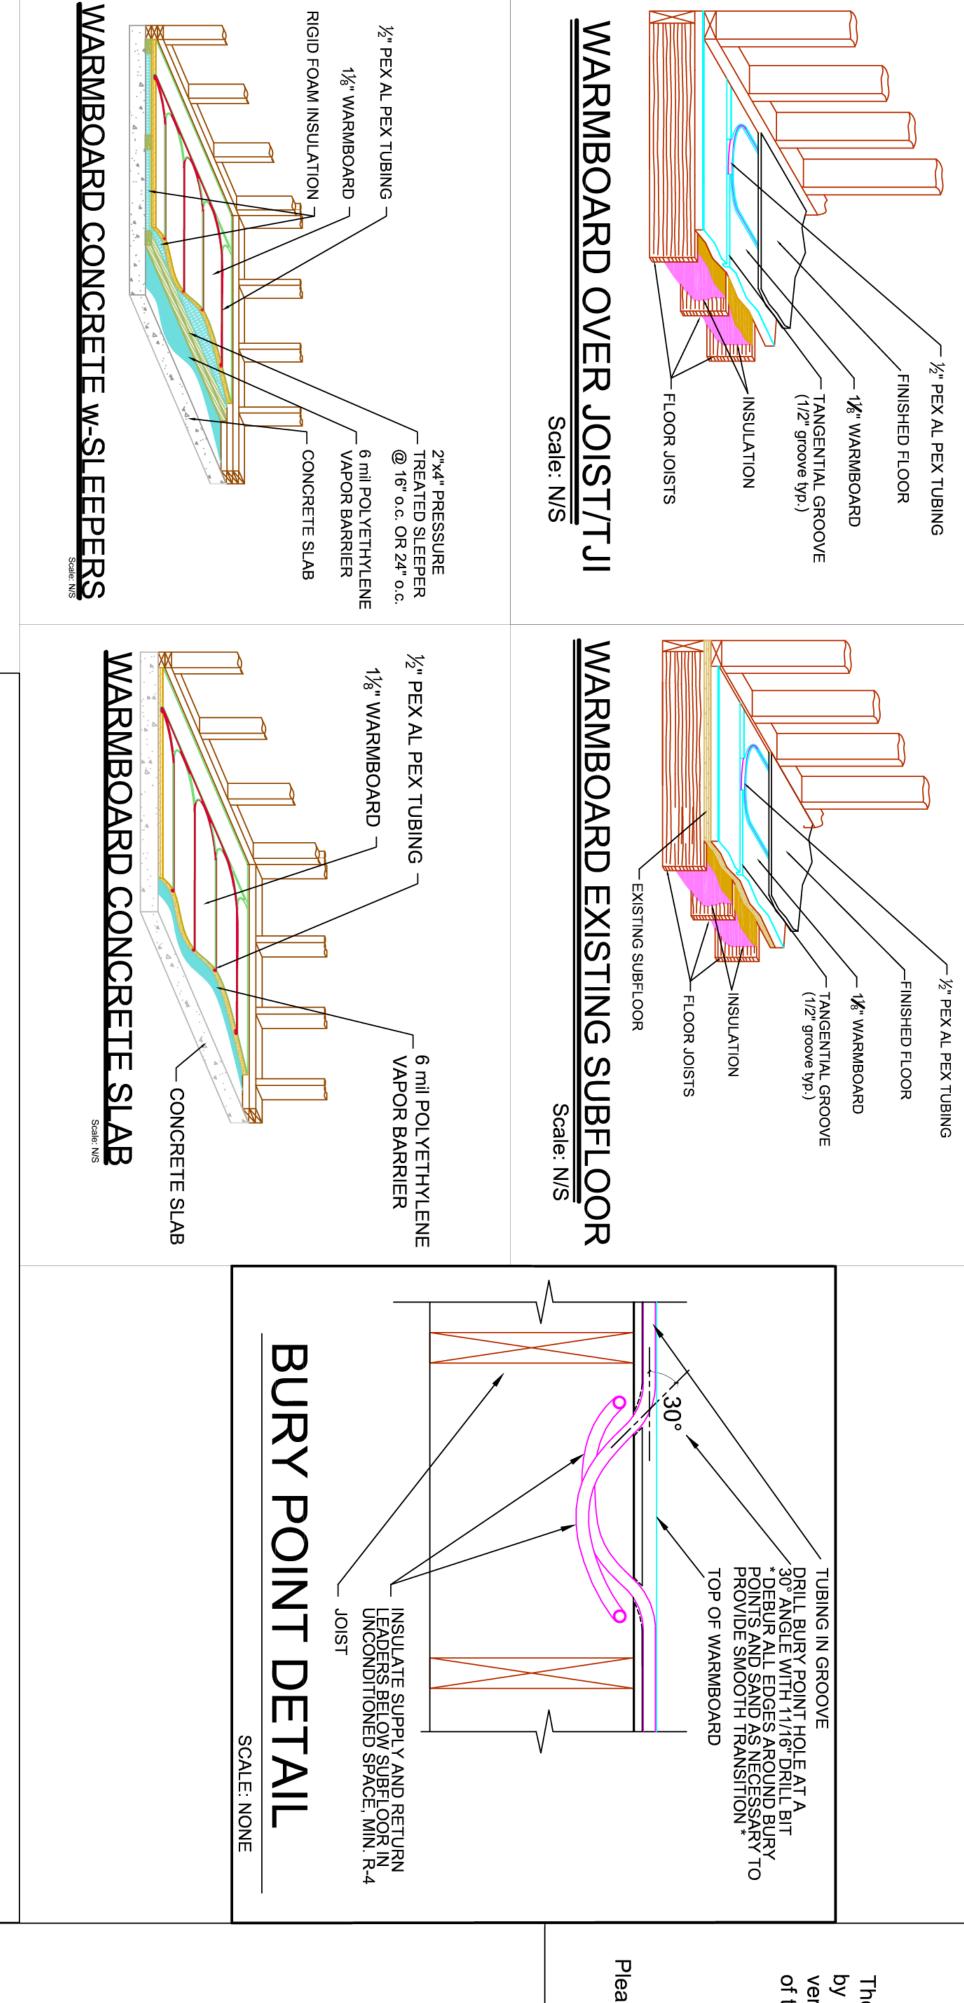

WARMBOA **SPECIFIC ATIONS**

A. GENERAL INFORMATION

LEFT TURN PANEL

Warmboard Radiant Subfloor is manufactured in the USA, and supplied by: Warmboard Inc. 8035 Soquel Drive, Ste 41A Aptos CA 95003 877-338-5493

刀

RIGHT TURN PANEL

ဟ

STRAIGHT PANEL

- 2. Warmboard panels shall be 4'x8' plywood, tongue and groove, with a thickness of 1-1/8".
- The entire top skin (4'x8') of plywood shall have a highly conductive continuous sheet of 1100 series aluminum alloy, bonded to the entire surface. Panels shall have 5/8" depth channels, consisting of straights and turns patterns, such channels on 12" centers to interface with 1/2" PEX aluminum PEX tubing.
- The continuous sheet of aluminum shall completely contour in all channels depths: both turns and straight runs.
- Panels shall be (4'x8') in one of the four tubing channel pattern options. Straight, Double, Turns (turns at one end), Left or Right (See Detail A.1).
- All panels installed will meet or exceed all specifications documented on Warmboard engineered AutoCAD drawings and Warmboard Installation manual. Supplied panels will meet or exceed APA certification and report #T2002Q-37
- Supplied panels will meet or exceed ICC Evaluation ESR# 1421

4. Panel assembly shall be one of the following:

- Warmboard structural subfloor installed over existing Joist or TJI. (See Detail B)
- Warmboard structural subfloor installed over existing concrete slab (See Detail C)
- Warmboard Structural subfloor installed Warmboard structural subfloor installed over existing structural plywood, decking or OSB. (See Detail E) over existing concrete slab with sleepers (See Detail D)


P

P CONVENTIONAL PLYWOOD PANEL

*HALF DOUBLE PANEL-RIGHT TURN
(Cut a Double panel in half to get this piece)

*HALF DOUBLE PANEL-LEFT TURN
(Cut a Double panel in half to get this piece)

D DOUBLE TURN PANEL

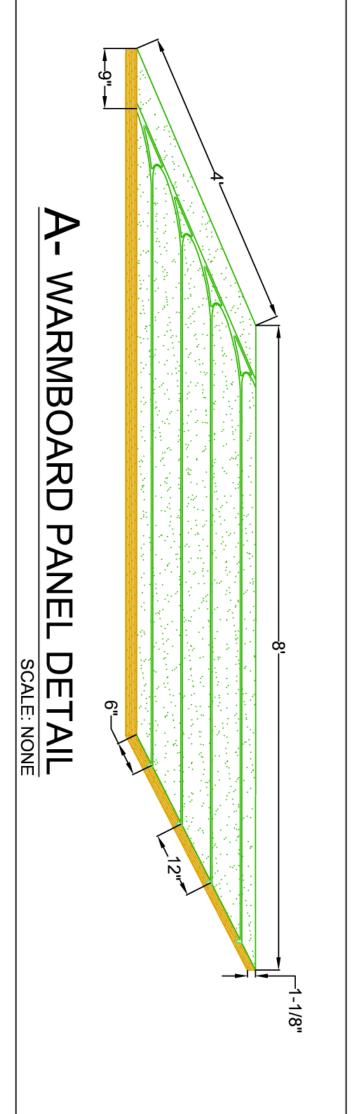

WARMBOARD PANEL

SCALE: NONE

HP HALF CONVENTIONAL PLYWOOD PANEL

WARMBOARD INSTALLATION NOTES

- MANDATORY:

REVISIONS:

The contractor(s) responsible for the installation of the Warmboard panels, as well as any hydronic tubing supplied by other, shall review these plans for accuracy and completeness. These contractors will also be responsible to verify all measurements prior to any Warmboard installtions. Any discrepancy between these plans an the framing of the project for which they apply shall be brought to the immediate attention of Warmboard, Inc.

WHEN

Please review all installation instructions. If there any questions

GENERAL INFORMATION

- 1. WARMBOARD IS ONE COMPONENT OF A HYDRONIC The general contractor shall be responsible for the skills, installers. Warmboard refers to floor framing information should be brought to the immediate attention of Warmboard, Inc. The hy follow the tubing layout plan and tubing installation instructions supplied floor and supply water temper responsible for providing an accurate heat loss analysis and system as a whole in accordance with Radiant Panel Associ system employing Warmboard PLAN COVERS ONLY PANEL AND TUBING LAYOUTS.
 COMPLETE INSTALLATION GUIDE FOR A HYDRONIC panels requires a combination of carpentry and plumbing skills. AND DOE training, and experience of the the installation of the hydronic ation (RPA) guidelines. Design S NOT CONSTITUTE A Installation of a hydronic Deviations
- It is the installer's responsibility local, state, and regional codes. the system functions properly, safely, and meets
- The installer is to supply and i The installer is to supply and install all materials shown on this plan; as well as all other materials needed to complete this hydronic system and any incidental work not shown c specified, which can be reasonably inferred as belonging to the work necessary to provi complete system.
- Warmboard makes no guarantee than the Warmboard panels. for any material to be installed in this hydronic system other

B. WARMBOARD INSTALLATION

- 1. WARMBOARD shall verify the Special attention shall be give compatibility of their layout with the attached floor framing plan.

 to the compatibility of Warmboard panels and joist layout.
- All supply and return tubing below pipe insulation.
- Custom grooves shall be routed as properly sized router equipped with a t All router use shall conform to supplied instructions, router you plan to use. indicated on the plans using supplied router templates, a template guide, and the supplied 5/8" core box router a template guide, supplied
- and all safety instructions provided by manufacturer of the

contractor shall coordinate with the plumbing contractor so as to

5. Alignment pins shall be used for proper alignment of panels

4. When applicable, installation

have all plumbing stubbed ou

- 6. Any excess adhesive that may interfere with tubing installation shall be
- 7. All burrs left by custom routing and angle holes shall be removed
- 8. Refer to manufacturer's installation manual for additional guidelines for

TUBING INSTALLATION

- Holes for routing below sub-the appropriate direction, so t the floor $1\%_6$ " bit at the correct location and in groove
- area in the right direction, leading to the appropriate manifold

2. All grooves shall be inspected and cleaned of any debris prior to tubing installation

SPECIFICATION &

INSTALLATION

INSTRUCTIONS

- Tubing for radiant floor heating 'ATSM'. ng shall be $\frac{1}{2}$ " PEX-AL-PEX (Pex-Aluminum-Pex) as listed by
- diaphragm for the duration of Tubing shall be and remain all construction pressurized immediately following installation into the panel
- Installer is responsible for protecting tubing from freezing during construction. conditions occur, this would require adding antifreeze and corrosion inhibiting f completion of work. inhibiting fluids upon Should climactic
- 6. Installer to record length of every pipe and photograph completed installation

into any unused groove areas.

Special note for carpeted areas:

This provides support for the pad & carpet. of PEX tubing (typically offcuts) shall be pressed SCALE:

DRAWN: J.N

REVIEWED:

J.McDONALD

SLN

SPE





WARMBOARD, INC. 8035 SOQUEL DR. SUITE 41-A

VOICE: (877)338-5493 FAX: (831)685-9278 WWW.WARMBOARD.COM EMAIL: PLANS@WARMBOARD.COM

APTOS, CA 95003

RADIANT HEAT"